



PARTIAL FIRST FLOOR LIGHTING PLAN
SCALE: 1/16"= 1'-0"

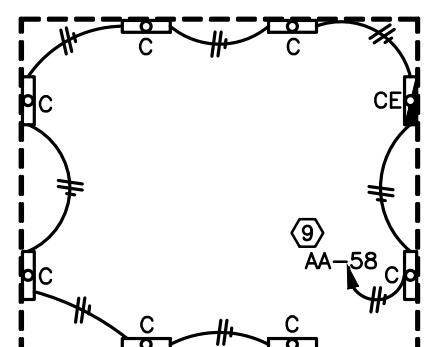

PIT "B" FLOOR LIGHTING PLAN
SCALE: 1/16"= 1'-0"

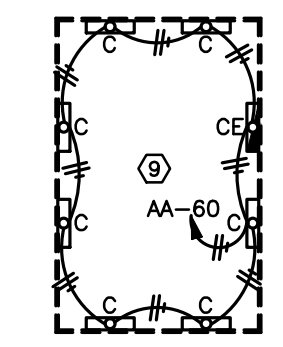


PIT "A" FLOOR LIGHTING PLAN
SCALE: 1/16"= 1'-0"

SHEET NOTES:


- ① LIGHT FIXTURE TO BE MOUNTED 13'-0" ABOVE FINISHED FLOOR.
- ② REFER TO TIME CLOCK/PHOTO CELL SCHEMATIC THIS SHEET.
- ③ LIGHTS IN THIS ROOM OR AREA TO BE WALL MOUNTED AT 9'-10" ABOVE FINISHED FLOOR.
- ④ TAG NOTE NOT USED
- ⑤ TAG NOTE NOT USED
- ⑥ LIGHTS IN THIS AREA ARE TO BE MOUNTED ON UNDER SIDE OF MEZZANINE FLOOR AT 10'-2" ABOVE FINISHED FLOOR.
- ⑦ TAG NOTE NOT USED
- ⑧ ALL LIGHTING IN THESE AREAS WILL BE AT SAME LEVEL, 2'-0" ABOVE CRANE.
- ⑨ CONTRACTOR TO LOCATE LIGHT SWITCH AT LADDER, SEE ARCHITECTURAL DETAILS.
- ⑩ MOUNT LIGHTS AT 7'-0" ABOVE FINISHED FLOOR.
- ⑪ AVIATION LIGHT - LIGHT FIXTURE "Y" TO BE MOUNTED ON SINGLE 5'-0" GALV. STEEL POLE, (ONE ON EACH CORNER OF ROOF) BOLTED TO STRUCTURE IN A WEATHERPROOF MANNER, FROM HIGHEST POINT OF ROOF LEVEL.
- ⑫ EXPLOSION PROOF SWITCH.

GENERAL NOTES:

- A. CONTRACTOR TO COORDINATE MOUNTING HEIGHT OF ALL UNMARKED LIGHT FIXTURES WITH THE OWNER.
- B. ALL EMERGENCY INVERTERS, BATTERY PACKS, EXIT SIGNS TO HAVE UNSWITCHED POWER SOURCE.

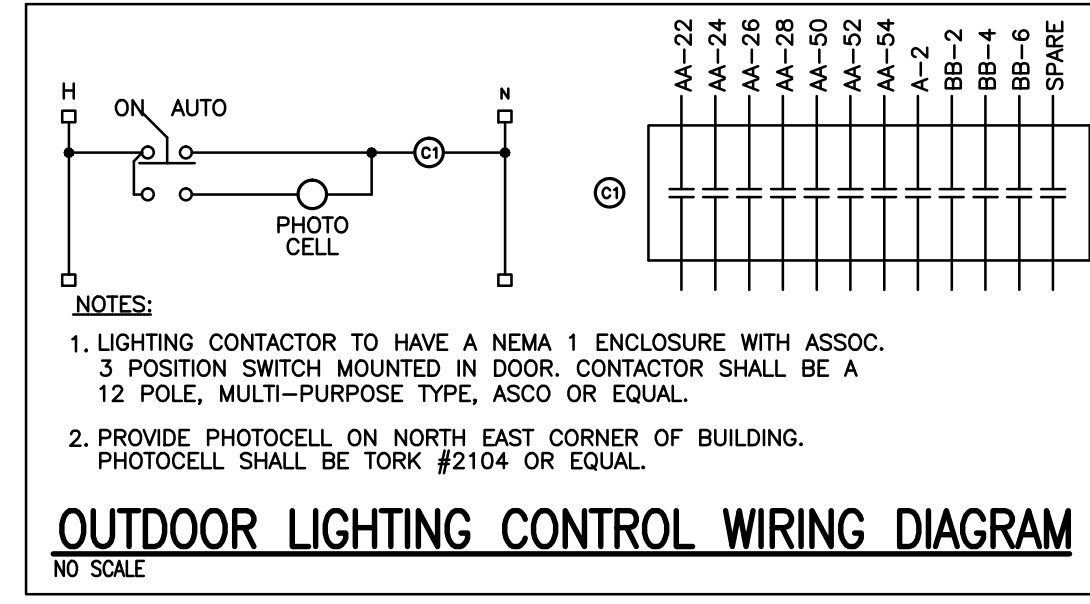

OUTDOOR LIGHTING CONTROL WIRING DIAGRAM
NO SCALE

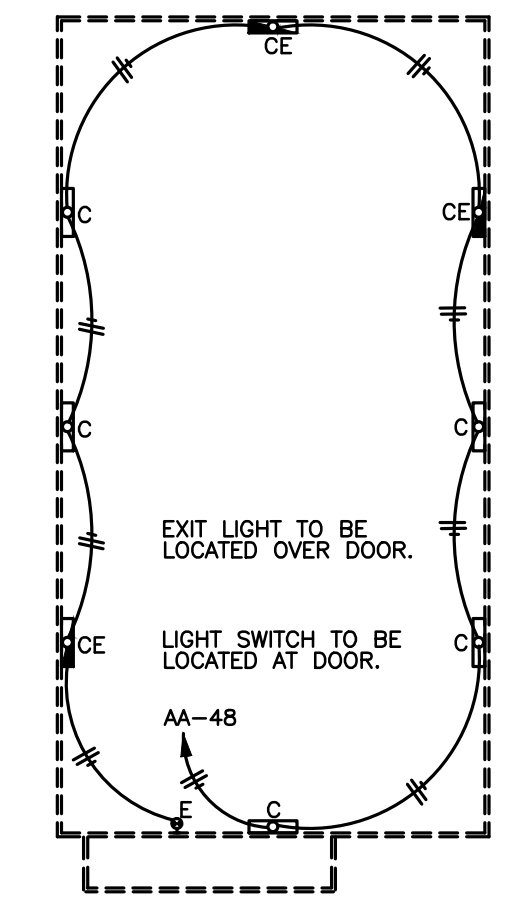

BASEMENT FLOOR LIGHTING PLAN
SCALE: 1/16"= 1'-0"

DATE	REVISION	BY
NOV. 1, 11	VALUE ENGINEERING RE-DESIGN DOCUMENT	
JAN. 20, 12	REVISIONS ASSOCIATED WITH REVISION FLOOR PLAN	

PROJECT NO. 8529-02	DESIGNED BY TBW	CHECKED BY TBW	DATE JULY 2011
DRAWN BY JVB	REVIEWED BY SHT	SCALE 1/16" AS NOTED	

